



DRIVEWAY PROFILE LOT 2 SCALE: HORZ: 1"=20' VERT: 1"=5' 3 OF 5

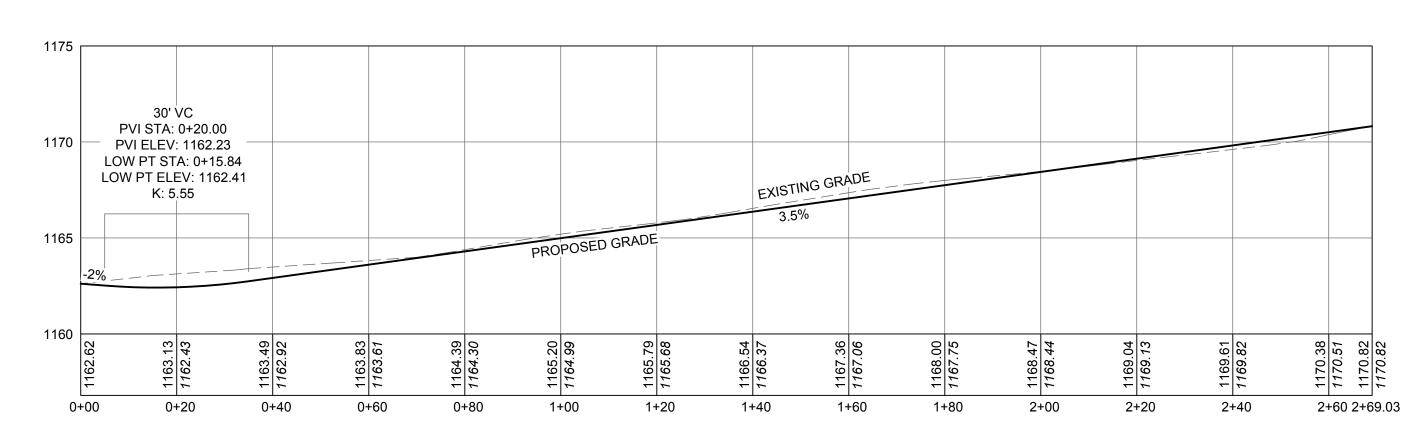

DRIVEWAY PROFILE LOT 3 3 SCALE: HORZ: 1"=20' VERT: 1"=5' 3 OF 5

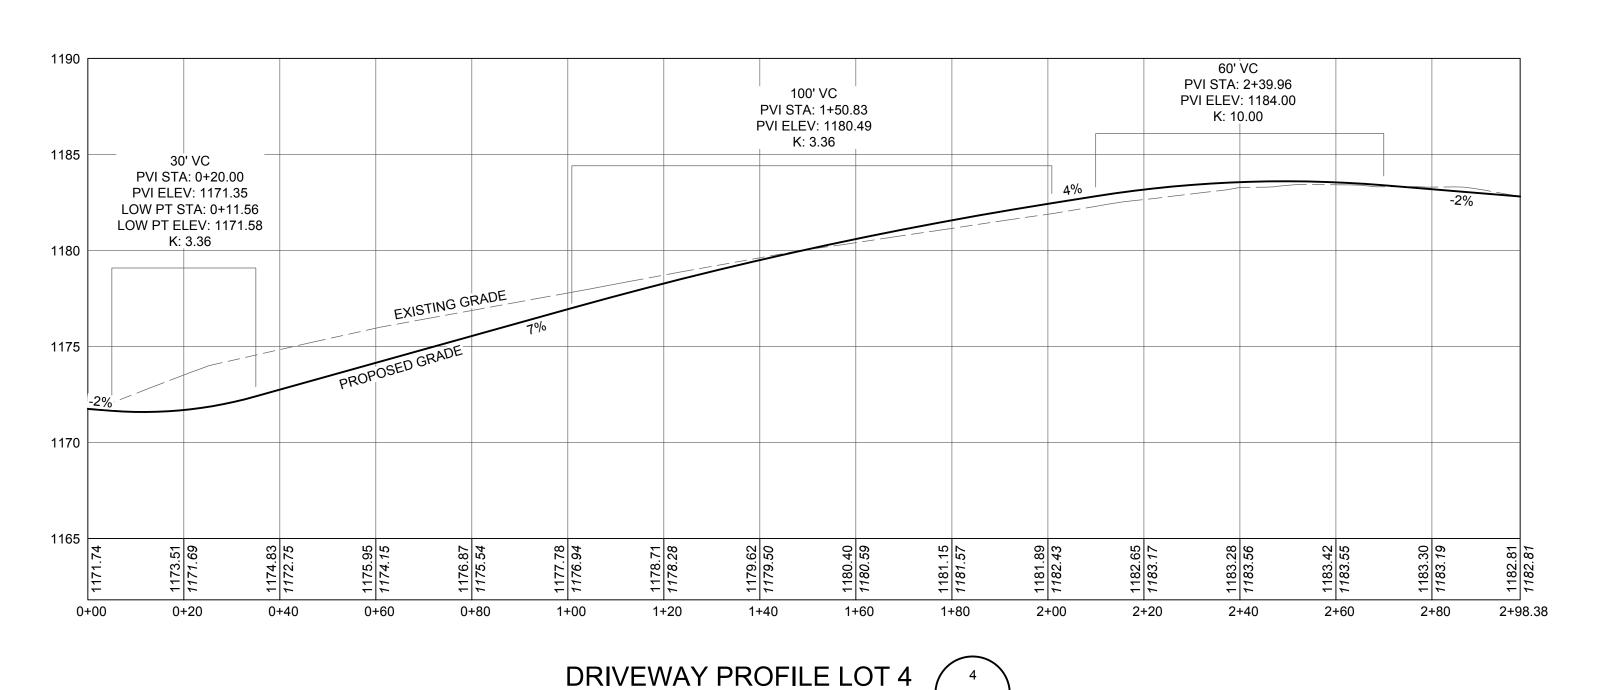

SCALE: HORZ: 1"=20'

VERT: 1"=5'

NOTES

1. ALL DRIVEWAYS SHALL PROVIDE INTERNAL TURN-AROUNDS.

2. ANY DRIVEWAY OVER 200' IN LENGTH SHALL BE CONSTRUCTED SO THAT NO SURFACE OR DRIVEWAY SURFACE WATER RUNS DOWN THE DRIVEWAY.

3. THE DRIVEWAY ENTRANCES SHALL BE PAVED FOR A MINIMUM OF 20 FEET IN LENGTH.

4. CULVERT REQUIREMENTS ARE 15" IN DIAMETER HDPE WITH FLARED END SECTIONS, MINIMUM OF 5 FEET FROM EDGE OF ROAD PAVEMENT.

5. ALL CUT MATERIAL SHALL BE TAKEN AWAY FROM THE DRIVEWAY LOCATION TO AVOID SEDIMENTATION OF THE NEW CONSTRUCTION.

6. ANY FILL SECTIONS SHALL BE COMPACTED TO A 70% PROCTOR.

TOWN OF DEERPARK PLANNING BOARD APPROVAL

THIS PLAN CONTAINS 5 SHEETS. THIS SHEET SHALL NOT BE CONSIDERED VALID UNLESS ACCOMPANIED BY THE REMAINING SHEETS.

UNAUTHORIZED ALTERATION OR ADDITIONS TO A PLAN BEARING

THE SEAL OF A LICENSED ENGINEER OR LAND SURVEYOR IS A VIOLATION OF SECTION 7209 SUBDIVISION 2 OF THE NEW YORK

COPIES OF THIS DOCUMENT WITHOUT A FACSIMILE OF THE

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STAMP IN BLUE OR RED INK OF THE PROFESSIONAL ENGINEER OR LAND SURVEYOR SHALL NOT BE CONSIDERED VALID COPIES.

STATE EDUCATION LAW.

REVISIONS DWN BY REV DESCRIPTION DATE APPROVED DL 0 FOR APPROVAL 09/16/20 DL 1 REVISED PER TOWN COMMENT 11/06/20

JOHN D. FULLER

REG. NO. 077703

JOHN D. FULLER, P.E., P.C. 4 SOUTH STREET PORT JERVIS, NY 12771 (845) 856-1536

PINE VIEW SUBDIVISION 76 WHITEHEAD ROAD SECTION 13 BLOCK 1 LOT 4.12 TOWN OF DEERPARK, NY

3 OF 5 DRIVEWAY PROFILES AS NOTED JOB NO. 2752.001

EROSION & SEDIMENT CONTROL NOTES

- 1. ALL SEDIMENT AND EROSION CONTROL MEASURES SHALL BE DONE IN ACCORDANCE WITH ANY AND ALL FEDERAL, STATE, AND LOCAL REGULATIONS.
- 2. THOSE AREAS UNDERGOING ACTUAL CONSTRUCTION WILL BE LEFT IN AN UNTREATED OR UNVEGETATED CONDITION FOR A MINIMUM TIME. AREAS SHALL BE PERMANENTLY STABILIZED WITHIN 15 DAYS OF FINAL GRADING AND TEMPORARY STABILIZED WITHIN 30 DAYS OF INITIAL DISTURBANCE OF THE SOIL IF THE DISTURBANCE IS WITHIN 100 FEET OF A STREAM OR POND. THE AREA SHALL BE STABILIZED WITHIN 7 DAYS OR PRIOR TO ANY STORM EVENT (THIS WOULD INCLUDE WETLANDS).
- 3. SEDIMENT BARRIERS (SILT FENCE, HAY BARRIERS, ETC.) SHOULD BE INSTALLED PRIOR TO ANY SOIL DISTURBANCE OF THE CONTRIBUTING DRAINAGE AREA ABOVE THEM. MULCH NETTING SHALL BE USED TO ANCHOR MULCH IN ALL AREAS WITH SLOPES GREATER THAN 15% AFTER OCTOBER 1ST THE SAME APPLIES FOR ALL SLOPES GREATER THAN 8%.
- 4. INSTALL SILT FENCE AT TOE OF SLOPE TO FILTER SILT FROM RUNOFF. SEE SILT FENCE DETAIL FOR PROPER INSTALLATION. SILT FENCE WILL REMAIN IN PLACE PER NOTE #5.
- 5. ALL EROSION CONTROL STRUCTURES WILL BE INSPECTED, REPLACED AND/OR REPAIRED EVERY 7 DAYS AND IMMEDIATELY FOLLOWING ANY SIGNIFICANT RAINFALL OR SNOW MELT OR WHEN NO LONGER SERVICEABLE DUE TO SEDIMENT ACCUMULATION OR DECOMPOSURE. SEDIMENT DEPOSITS SHOULD BE REMOVED AFTER EACH STORM EVENT. THEY MUST BE REMOVED WHEN DEPOSITS REACH APPROXIMATELY ONE HALF THE HEIGHT OF THE BARRIER. SEDIMENT CONTROL DEVICES SHALL REMAIN IN PLACE AND BE MAINTAINED BY THE CONTRACTOR UNTIL AREAS UPSLOPE ARE STABILIZED BY TURF.
- 6. NO SLOPES, EITHER PERMANENT OR TEMPORARY, SHALL BE STEEPER THAN TWO TO ONE (2 TO 1).
- 7. IF FINAL SEEDING OF THE DISTURBED AREAS IS NOT COMPLETED 45 DAYS PRIOR TO THE FIRST KILLING FROST USE TEMPORARY MULCH (DORMANT SEEDING MAY BE ATTEMPTED AS WELL) TO PROTECT THE SITE AND DELAY SEEDING UNTIL THE NEXT RECOMMENDED SEEDING PERIOD.
- 8. THE TEMPORARY SEEDING OF DISTURBED AREAS THAT HAVE NOT BEEN FINAL GRADED SHALL BE COMPLETED 45 DAYS PRIOR TO THE FIRST KILLING FROST TO PROTECT FROM SPRING RUNOFF PROBLEMS.
- 9. DURING THE CONSTRUCTION PHASE, INTERCEPTED SEDIMENT WILL BE RETURNED TO SITE AND REGRADED ONTO OPEN AREAS.
- 10. ALL TEMPORARY EROSION CONTROL MEASURES SHALL BE REMOVED ONCE THE SITE IS STABILIZED.


SEEDING AND MULCHING SPECIFICATIONS

TEMPORARY STABILIZATION:

	TYPE	RATE
SEED	ANNUAL RYE GRASS	1 LB/1,000 SQ
MULCH	HAY	3.0 TONS/ACR
LIME	AGRICULTURAL GRADE LIMESTONE	1.0 TONS/ACR
FERTILIZER	10-20-10	50 LBS./ACRE

PERMANENT STABILIZATION:

-		
	TYPE	<u>RATE</u>
SEED	PERENNIAL RYE GRASS (20%) REDTOP (50%) ORCHARD GRASS (30%)	0.45 LBS/1,000 SQ I 0.35 LBS/1,000 SQ I 1.4 LBS/1,000 SQ I
MULCH	HAY	3.0 TONS/ACRE
LIME	AGRICULTURAL GRADE LIMESTONE	6.0 TONS/ACRE
FERTILIZER	10-20-10	1,000 LBS./ACRE

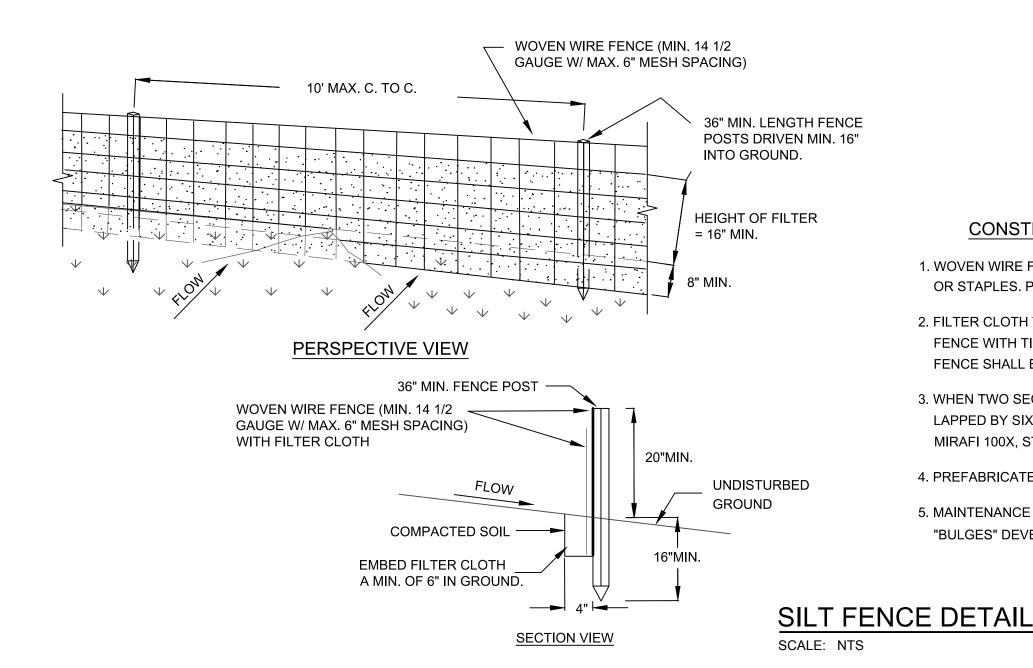

CONSTRUCTION SPECIFICATIONS

2. FILTER CLOTH TO BE TO BE FASTENED SECURELY TO WOVEN WIRE FENCE WITH TIES SPACED EVERY 24" AT TOP AND MID SECTION.

MIRAFI 100X, STABILINKA T140N, OR APPROVED EQUIVALENT.

"BULGES" DEVELOP IN THE SILT FENCE.

FENCE SHALL BE WOVEN WIRE, 12 1/2 GAUGE, 6" MAXIMUM MESH OPENING.


1. WOVEN WIRE FENCE TO BE FASTENED SECURELY TO FENCE POSTS WITH WIRE TIES OR STAPLES. POSTS SHALL BE STEEL EITHER "T" OR "U" TYPE OR HARDWOOD.

3. WHEN TWO SECTIONS OF FILTER CLOTH ADJOIN EACH OTHER THEY SHALL BE OVER-

4. PREFABRICATED UNITS SHALL BE GEOFAB, ENVIROFENCE, OR APPROVED EQUIVALENT.

LAPPED BY SIX INCHES AND FOLDED. FILTER CLOTH SHALL BE EITHER FILTER X,


5. MAINTENANCE SHALL BE PERFORMED AS NEEDED AND MATERIAL REMOVED WHEN

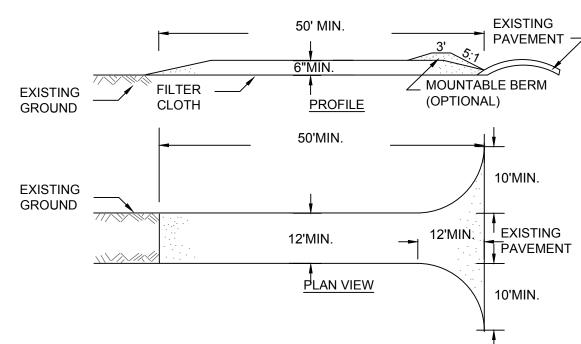


CONSTRUCTION SPECIFICATIONS

- 1. STONE SIZE = USE 2" STONE, OR RECLAIMED OR RECYCLED CONCRETE EQUIVALENT.
- 2. LENGTH = NOT LESS THAN FIFTY (50) FEET (EXCEPT ON A SINGLE RESIDENCE LOT WHERE A 30 FOOT MINIMUM LENGTH WOULD APPLY).
- 3. THICKNESS = NOT LESS THAN SIX (6) INCHES.
- 4. WIDTH = TWELVE (12) FOOT MINIMUM, BUT NOT LESS THAN THE FULL WIDTH AT POINTS WHERE INGRESS OR EGRESS OCCUR. TWENTY-FOUR (24) FEET IF SINGLE ENTRANCE TO SITE.
- 5. FILTER CLOTH WILL BE PLACED OVER THE ENTIRE AREA PRIOR TO PLACING OF STONE.
- 6. SURFACE WATER ALL SURFACE WATER FLOWING OR DIVERTED TOWARD CONSTRUCTION ENTRANCES SHALL BE PIPED ACROSS THE ENTRANCE. IF PIPING IS IMPRACTICAL, A MOUNTABLE BERM WITH 5:1 SLOPES WILL BE PERMITTED.
- 7. MAINTENANCE THE ENTRANCE SHALL BE MAINTAINED IN A CONDITION WHICH WILL PREVENT TRACKING OR FLOWING OF SEDIMENT ONTO PUBLIC RIGHTS-OF-WAY. ALL SEDIMENT SPILLED, DROPPED, WASHED OR TRACKED ONTO PUBLIC RIGHTS-OF-WAY MUST BE REMOVED IMMEDIATELY.
- 8. WHEN WASHING IS REQUIRED, IT SHALL BE DONE ON AN AREA STABILIZED WITH STONE AND WHICH DRAINS INTO AN APPROVED SEDIMENT TRAPPING DEVICE.
- 9. PERIODIC INSPECTION AND NEEDED MAINTENANCE SHALL BE PROVIDED AFTER EACH RAIN.



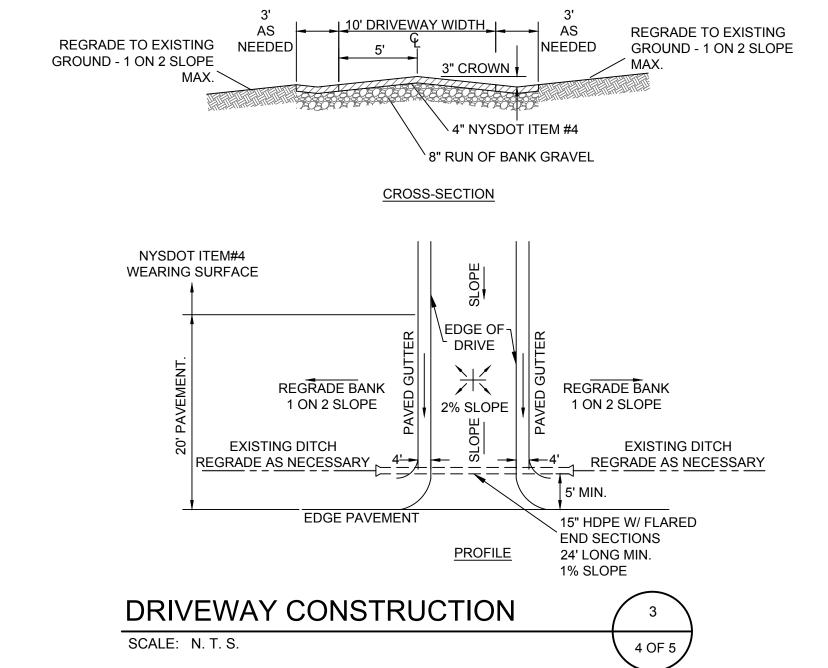


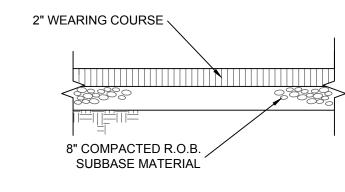

PAVING DETAIL (APRON)


4 4 OF 5


	SCALE:		<u> </u>	AIL (APRON) 4 OF 5				
								TOWN OF DEERPARK PLANNING BOARD APPROVAL
THIS PLAN CONTAINS 5 SHEETS. THIS]			REVISIONS				4 SOUTH STREE
SHEET SHALL NOT BE CONSIDERED VALID UNLESS ACCOMPANIED BY THE		DWN BY	REV	DESCRIPTION	DATE	APPROVED	Λ	JOHN D. FULLER, P.E., P.C. PORT JERVIS, N' (845) 856-1536
REMAINING SHEETS.		DL	0 FC	DR APPROVAL	09/16/20		1. 1/1	
		DL	1 RE	EVISED PER TOWN COMMENT	11/06/20		1/1 / Klen.	PINE VIEW SUBDIVISION
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NAUTHORIZED ALTERATION OR ADDITIONS TO A PLA HE SEAL OF A LICENSED ENGINEER OR LAND SURVE IOLATION OF SECTION 7209 SUBDIVISION 2 OF THE N TATE EDUCATION LAW. OPIES OF THIS DOCUMENT WITHOUT A FACSIMILE OR IGNATURE AND AN ORIGINAL EMBOSSED SEAL OR OF TAMP IN BLUE OR RED INK OF THE PROFESSIONAL E AND SURVEYOR SHALL NOT BE CONSIDERED VALID	NEW YORK OF THE DRIGINAL ENGINEER OR						JOHN D. FULLER REG. NO. 077703	DWG TITLE SITE DETAILS DWG NO. 4 O

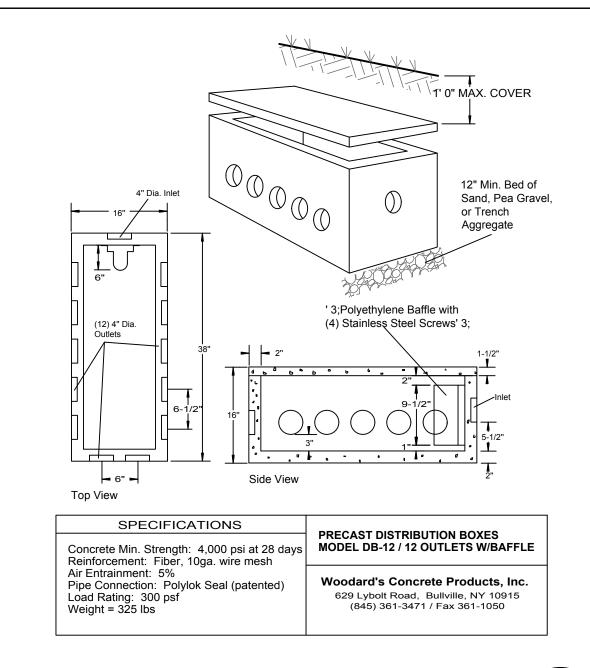


PRECAST DISTRIBUTION BOX DETAIL

SCALE: N.T.S.

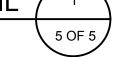


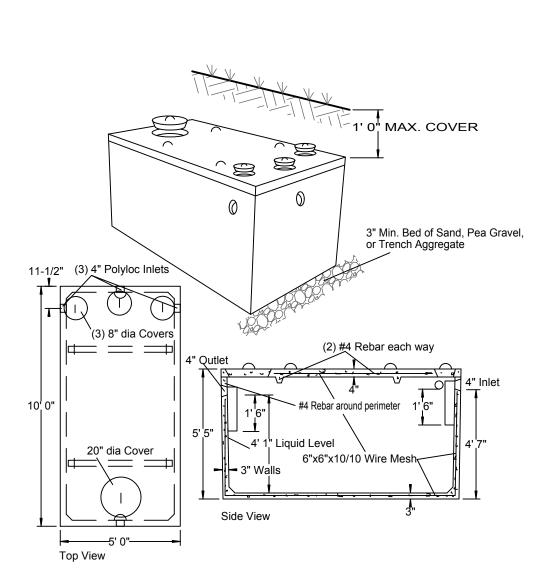


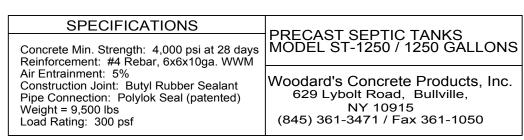


TYPICAL CONCRETE SEPTIC TANK


SCALE: N.T.S.

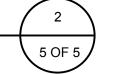

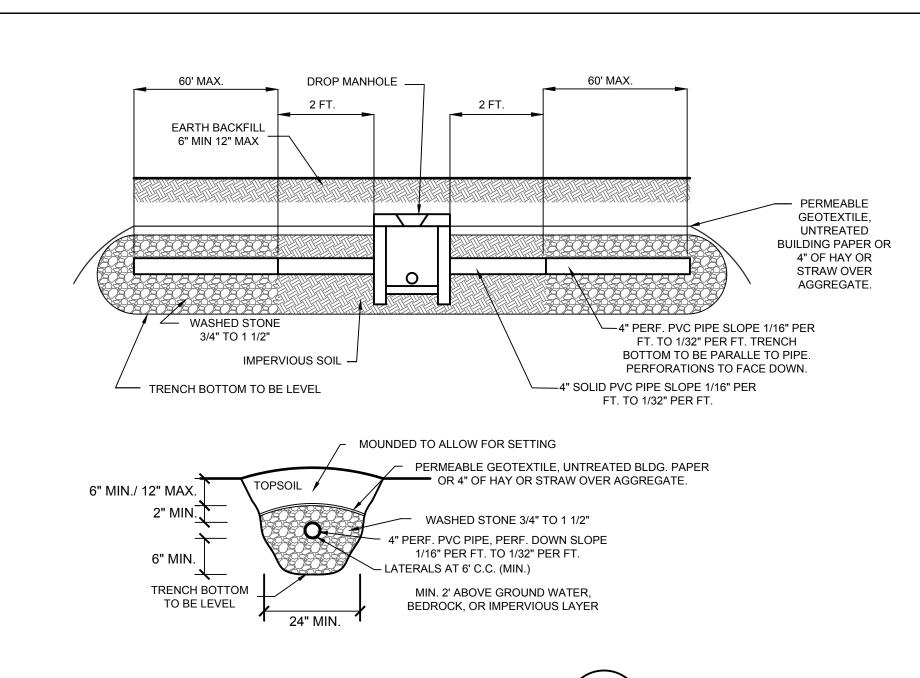

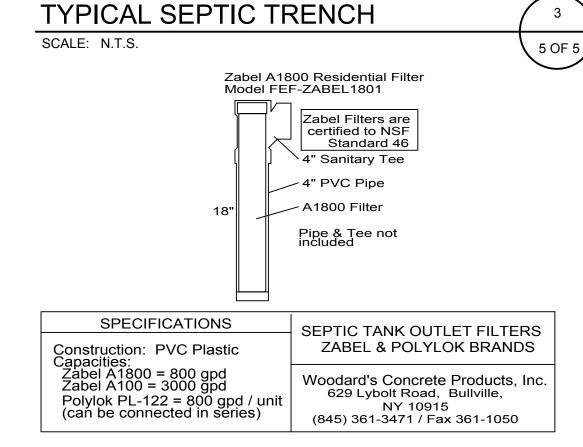

TYPICAL EFFLUENT FILTER FOR SEPTIC TANK / 4

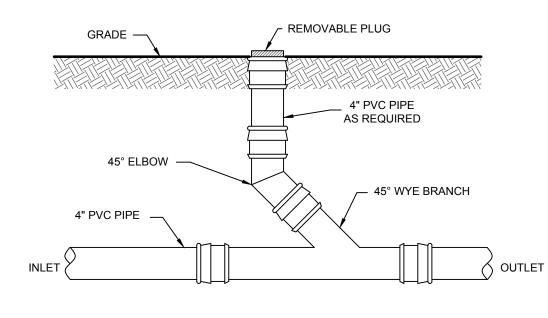




—PROPERTY LINE (TYP) -CONTOUR LINES MEAN HIGH (2' INTERVALS) WATER MARK WELL | STREAM POND HOUSE HOUSE **50% EXPANSION** SEPTIC TANK— -ABSORPTION **FIELD** STREET **DISTRIBUTION BOX-**

1. NO TILE FIELD TO BE WITHIN 100 FEET

- OF A WATERCOURSE. 2. MINIMUM DISTANCE BETWEEN THE BUILDING
- WATER SERVICE AND SEWERAGE TO BE 10FT.
- 3. NO TILE FIELD TO BE WITHIN 50 FT. OF A DRAINAGE DITCH

TYPICAL LOT DIMENSIONS SCALE: N.T.S.

5 OF 5

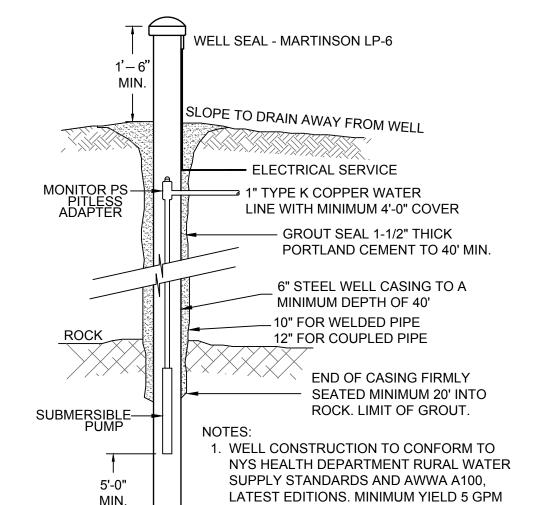

2. INSTALL TOP OF CASING MINIMUM 24"

ABOVE ANY FLOOD LEVEL.

1. WELL CONSTRUCTION SHALL CONFORM TO THE MINIMUM STANDARDS SET FORTH

5. WELLS MUST BE INSTALLED AT LEAST 100 FEET FROM ALL SEPTIC SYSTEMS AND

WATER SYSTEM NOTES

BY THE N.Y.S. DEPARTMENT OF HEALTH FOR RURAL WATER SUPPLY

3. THE LOCATION OF WELLS AND SEPTIC FIELDS SHALL NOT BE CHANGED.

200 FEET FROM ANY SEPTIC SYSTEM WHICH IS UPHILL FROM THE WELL.

6. WELL CASING IS TO BE INSTALLED 20 FEET INTO IMPERVIOUS BEDROCK.

4. FOOTING DRAINS WITHIN 25 FEET OF A WELL SHALL BE WATERTIGHT.

2. SOFTENING OF HARD WATER SHOULD BE CONSIDERED ONLY IF EXCESSIVE.

TYPICAL 6" WELL

HARDNESS IS FOUND. (GREATER THAN 150 MG/L).

THIS PLAN CONTAINS 5 SHEETS. THIS

LAND SURVEYOR SHALL NOT BE CONSIDERED VALID COPIES.

SCALE: N.T.S.

- 1. THE USE OF POST 1991 WATER SAVING FIXTURES ARE REQUIRED IN THE DWELLING.
- "INDIVIDUAL RESIDENTIAL WASTEWATER TREATMENT SYSTEM DESIGN HANDBOOK", NEW YORK STATE DEPARTMENT OF HEALTH 1996 ED., TABLE 1-DESIGN FLOWS FOR VARIOUS HOUSEHOLD PLUMBING.

MINIMUM SEPARATION DISTANCE (FEET) FROM TO STDEAM LAKE CVCTEM COMPONIENTS

SYSTEM COMPONENTS WE	ELL OR	TO STREAM, LAK	Œ,		
SU	CTION LINE	WATERCOURSE	(b)	PROPERTY	DRAINAGE DITCH OR
	(e) (g)	OR WETLAND	DWELLING	LINE	RAIN GARDENS (h)
	25' IF CAST IRON, 50' OTHERWISE	25'	3'	10'	10'
SEPTIC TANK	50'	50'	10'	10'	10'
EFFLUENT LINE TO DISTRIBUTION BOX	50'	50'	10'	10'	10'
DISTRIBUTION BOX	100'	100'	20'	10'	20'
ABSORPTION FIELD (c) (d)	100' (a)	100'	20'	10'	20'
SEEPAGE PIT (d)	150' (a)	100'	20'	10'	20'
RAISED OR MOUND SYSTEM (c) (d)	100' (a)	100'	20'	10'	20'
INTERMITTENT SAND FILTER (d)	100' (a) (f)	100' (f)	20'	10'	20'
NON-WATERBORNE SYSTEMS WITH OFFSITE RESIDUAL DISPOSAL	50'	50'	20'	10'	10'
NON-WATERBORNE SYSTEMS WITH ONSITE DISCHARGE	100'	50'	20'	10'	20'

- (a) WHEN WASTEWATER TREATMENT SYSTEMS ARE LOCATED UPGRADE AND IN THE DIRECT PATH OF SURFACE WATER DRAINAGE TO A WELL, THE CLOSEST PART OF THE TREATMENT SYSTEM SHALL BE AT LEAST 200 FEET AWAY FROM THE WELL
- (b) MEAN HIGH WATER MARK. WETLAND OR WATERCOURSE DETERMINATIONS SHOULD BE ADDRESSED WITH THE LHD OR OTHER AGENCY HAVING JURISDICTION AND THE APPLICABLE NYSDEC REGIONAL OFFICE.
- (c) FOR ALL SYSTEMS INVOLVING THE PLACEMENT OF FILL MATERIAL, SEPARATION DISTANCES ARE MEASURED FROM THE TOE OF SLOPE OF THE FILL, EXCEPT FOR SOME SHALLOW ABSORPTION TRENCH SYSTEMS AS DESCRIBED IN SECTION 9.12.2 OF THE HANDBOOK.
- (d) SEPARATION DISTANCES SHALL ALSO BE MEASURED FROM THE EDGE OF THE DESIGNATED ADDITIONAL USEABLE AREA (i.e., RESERVE AREA), WHEN AVAILABLE.
- (e) THE CLOSEST PART OF THE WASTEWATER TREATMENT SYSTEM SHALL BE LOCATED AT LEAST TEN (10) FEET FROM ANY WATER SERVICE LINE (e.g., PUBLIC WATER SUPPLY MAIN, PUBLIC WATER SERVICE LINE OR
- (f) WHEN INTERMITTENT SAND FILTERS ARE DESIGNED TO BE WATERTIGHT AND COLLECT ALL EFFLUENT, THE SEPARATION DISTANCE CAN BE REDUCED TO 50 FEET.

RESIDENTIAL WELL WATER SERVICE LINE).

- (g) THE LISTED WATER WELL SEPARATION DISTANCES FROM CONTAMINANT SOURCES SHALL BE INCREASED BY 50% WHENEVER AQUIFER WATER ENTERS THE WATER WELL AT LESS THAN 50 FEET BELOW GRADE. IF A 50% INCREASE CANNOT BE ACHIEVED, THEN THE GREATEST POSSIBLE INCREASE IN SEPARATION DISTANCE
- SHALL BE PROVIDED WITH SUCH ADDITIONAL MEASURES AS NEEDED TO PREVENT CONTAMINATION. (h) RECOMMENDED; USE SITE EVALUATION TO AVOID OWTS SHORT-CIRCUITING TO THE SURFACE OR GROUNDWATER AND TO MINIMIZE IMPACTS ON OWTS FUNCTIONALITY.

EMBANKMENT OR VERY STEEP SLOPE: IT IS RECOMMENDED THAT SYSTEM COMPONENTS BE LOCATED A MINIMUM OF 25 FEET AND THE ABSORPTION FIELD BE LOCATD A MINIMUM OF 50 FEET FROM AN EMBANKMENT OR VERY STEEP SLOPE. MAXIMIZE SEPARATION DISTANCES AND USE SITE EVALUATION TO AVOID SHORT-CIRCUITING TO SURFACE (BREAKOUT OR SEEPAGE).

SWIMMING POOLS (ABOVE OR BELOW GROUND): IT IS RECOMMENDED THAT SYSTEM COMPONENTS BE LOCATED A MINIMUM OF 20 FEET AND THE ABSORPTION FIELD BE LOCATED A MINIMUM OF 35 FEET FROM SWIMMING POOLS. MAXIMIZE SEPARATION DISTANCES AND USE SITE EVALUATION TO MINIMIZE IMPACTS ON OWTS ACCESSIBILITY AND FUNCTIONALITY.

WATER SAVING FIXTURES NOTES

5 OF 5

- 2. POST 1991 WATER SAVING FIXTURES SHALL BE AS DEFINED IN
- 3. WATER SAVING PLUMBING FIXTURES SHALL BE DEFINED AS FOLLOWS: A) 1.6 GAL PER FLUSH WATER CLOSETS. B) 3.0 GPM MAX. FAUCETS / SHOWERHEADS.

LOT NO.	PERC. RATE (MIN.)	TRENCH MIN. WIDTH INCHES	Т	ENGTH (ILE FIEL RED (LI	.D	4 BEDROOM	
			2 BR.	3 BR.	4 BR.		
	1-5	24	92	138	184		
	6-7	24	110	165	220		
	8-10	24	123	184	245		
	11-15	24	138	207	275	8 LATERALS	
	16-20	24	158	236	315	@ 46 L.F. =	
13-1-4.12	21-30	24	184	275	367	368 L.F. TOTAL	
	31-45	24	220	330	440	PROVIDED	
	46-60	24	245	367	489	PROVIDED	
SIZE OF SEPTIC TANK REQUIRED (GAL.)			1000	1250			

NOTE: DESIGN BASED ON 130 GPD PER BEDROOM

MINIMUM SEPTIC TANK CAPACITIES


NUMBER OF BEDROOMS	MINIMUM TANK CAPACITY (GALLONS)	MINIMUM LIQUID SURFACE AREA (SQ.FT.)
1, 2, OR 3	1,000	27
4	1,250	34
5	1,500	40
e	1 750	47

NOTE: TANK SIZE REQUIREMENTS FOR MORE THAN SIX BEDROOMS SHALL BE CALCULATED BY ADDING 250 GALLONS AND SEVEN SQUARE FEET OF SURFACE AREA FOR EACH ADDITIONAL BEDROOM. A GARBAGE GRINDER SHALL BE CONSIDERED EQUIVALENT TO AN ADDITIONAL BEDROOM FOR DETERMINING TANK SIZE. A HOT TUB/SPA SHOULD BE CONSIDERED EQUIVALENT TO AN ADDITIONAL BEDROOM FOR DETERMINING TANK SIZE.

1. ALL LATERALS IN USE SHALL BE EQUIPPED WITH A FLOW LEVELER. 2. FLOW LEVELERS SHALL NOT COMPENSATE FOR MORE THAN 1 1/4" DIFFERENCE IN LATERAL INVERT ELEVATIONS. THE DISTRIBUTION BOX SHALL BE RELEVELED AND THE FLOW LEVELERS READJUSTED.

REG. NO. 077703

3. THE DISTRIBUTION BOX SHALL BE CHECKED 6-12 MONTHS AFTER INSTALLATION AND THE FLOW LEVELERS SHALL BE READJUSTED IF NECESSARY.

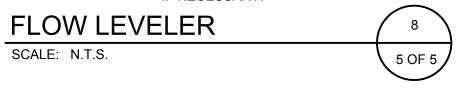

	SHEET SHALL NOT BE CONSIDERED VALID UNLESS ACCOMPANIED BY THE		REVISIONS				
	REMAINING SHEETS.	DWN BY	REV	DESCRIPTION	DATE	APPROVED	Λ
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JOHN D. FULLER, P.E., P.C. PORT JERVIS, NY 12771 PINE VIEW SUBDIVISION

76 WHITEHEAD ROAD SECTION 13 BLOCK 1 LOT 4.12 TOWN OF DEERPARK, NY

4 SOUTH STREET

TOWN OF DEERPARK

PLANNING BOARD APPROVAL

5 OF 5 SEPTIC DETAILS AS NOTED JOB NO. 2752.001